


LEGEND	
	SEWER LINE
	DRAIN LINE
	TUBE WELL WATER LINE
	MUNICIPAL WATER LINE
	DOMESTIC WATER SUPPLY LINE
	IRRIGATION WATER SUPPLY LINE
	GARDEN WIDRANT
	VALVE
	VALVE CHAMBER, (300x300)mm
	VALVE CHAMBER, (400x400)mm
	SEWER MANHOLE, (400x400)mm
	SEWER MANHOLE - CIRCULAR
	CATCH BASIN, (400x400)mm
	DRAIN MANHOLE - CIRCULAR
	DEGULTING TANK, AS/CALCULATION
	RECHARGE PIT, AS/CALCULATION
	G.L. GROUND LEVEL
	LL. INVERT LEVEL
	C.L. CONNECTION LEVEL

NOTE:-

- Catch basin to drain manhole pipe dia to 150mm and slope to 1:50 and starting depth of catch basin will be 750mm.
- Sewer manhole (300x400)mm to sewer manhole - circular pipe dia to 150mm and slope to 1:50 and starting depth of sewer manhole will be 750mm.
- The area of catch pit / manhole shall be as under (near 400x400):
 - a) Up to 100 m. depth 400 x 400 m.m.
 - b) 100 to 150 m. depth 500 m.m. dia.
 - c) 150 to 200 m. depth 1000 m.m. dia.
 - d) Above 200 m. depth 1500 m.m. dia.

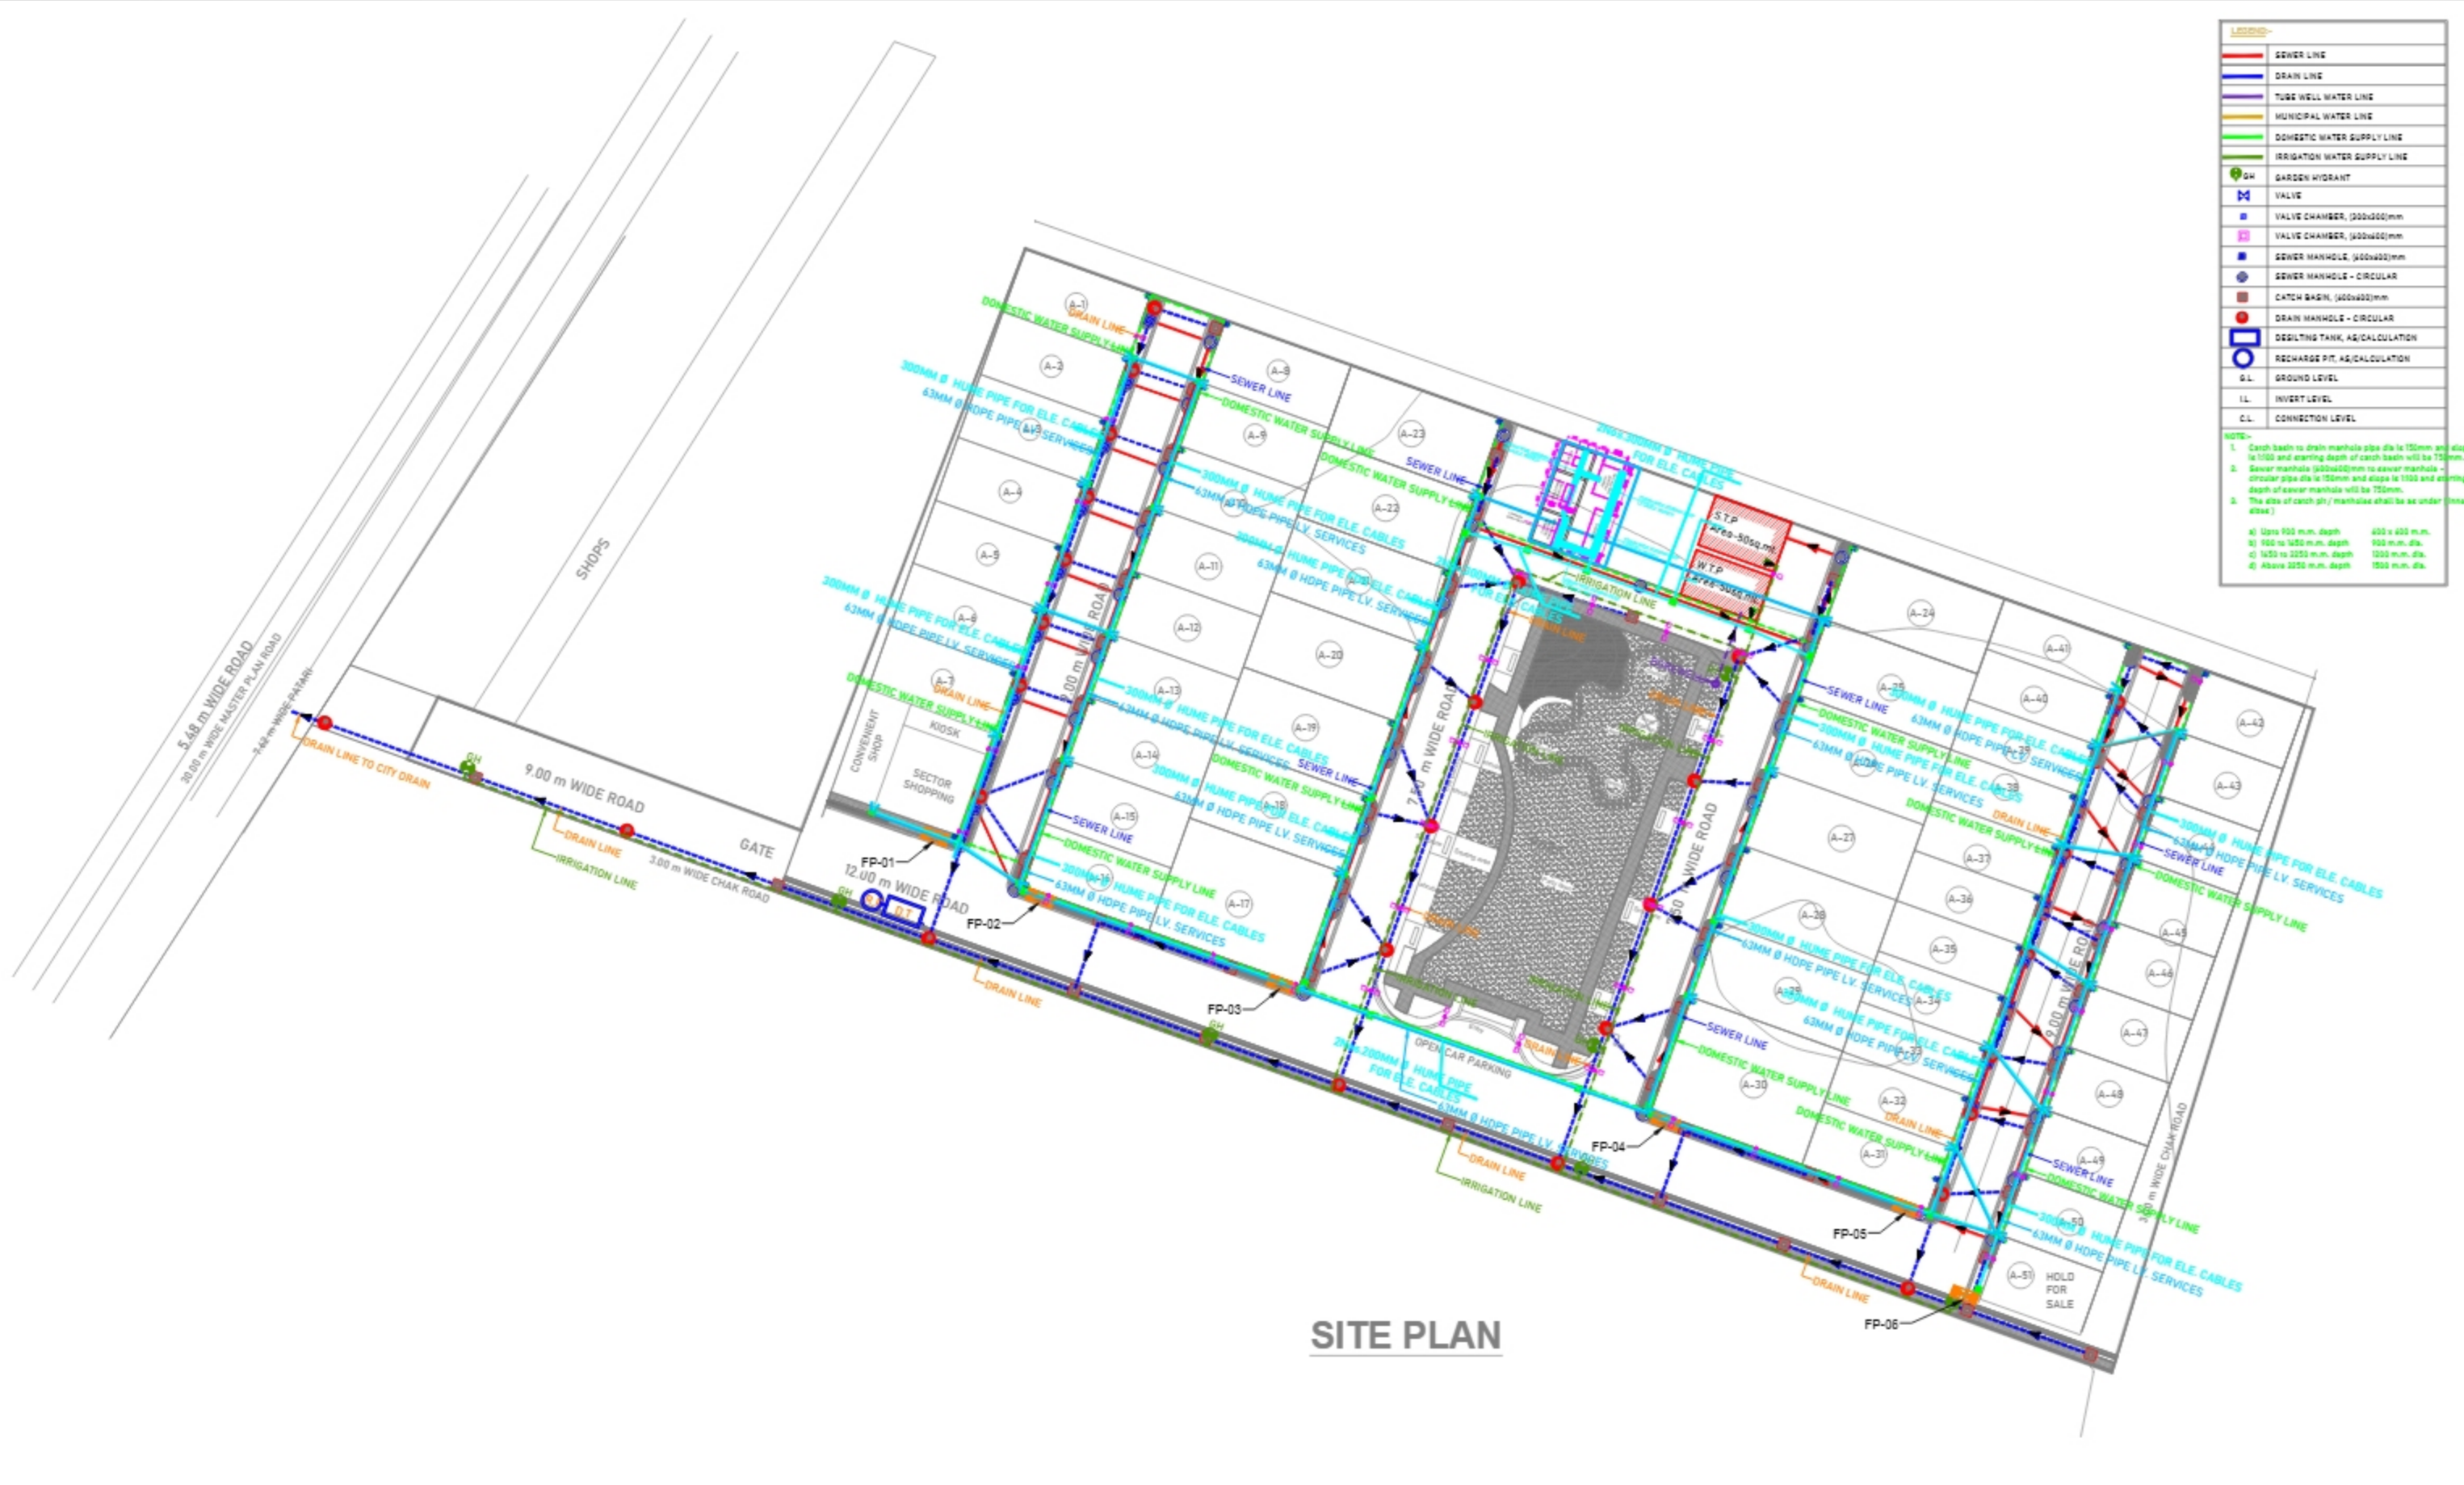

SITE PLAN

GENERAL NOTES

- All designs are based on applicable standards including: National Building Code of India 2016 (Part IX - Plumbing) IS 1172, IS 2065, CPHEEO Manual Relevant local authority norms and bye-laws
- Pipe routing, sizing, and equipment locations are indicative and to be verified on-site prior to installation. Final execution shall be adjusted to suit actual site conditions.
- The drawings must be read in conjunction with architectural, structural, electrical, HVAC, and other relevant services drawings.
- All dimensions are in millimetres unless otherwise specified.
- Contractor shall verify all site dimensions, levels, and coordinates before starting execution.
- All materials, valves, pumps, fixtures, and equipment shall be ISI marked or approved as per project specifications and local standards.
- Pressure testing of pipelines (hydrostatic and air) shall be carried out as per IS code and shall be witnessed by the Engineer/Consultant.
- All installations shall be carried out by licensed agencies as per statutory authority norms.
- These drawings are conceptual/design intent and not to be used for statutory submission unless signed by the licensed architect or authority-approved engineer.
- Accurate Design Consultants shall not be held liable for modifications, deviations, or execution errors done without written design change approval.

NO.	DATE	BY	SEND TO

NO.	DATE	DESCRIPTION

CLIENT
GEO SPAR DEVELOPERS

ARCHITECT
SIGNITIVE DESIGN STUDIO
ARCHITECT: ROHIT DHINGRA
Contact - 9810483707, 8810352620
SIGNITIVEDESIGNSTUDIO@GMAIL.COM
DELHI: GURGAON

PROJECT
PROPOSED LAYOUT PLAN OF "AERO MAUZA" FOR INFORMATION THROUGH SIVANTRAJ SERVICES INDIA LIMITED AT PLOT NO.- 1072, 1073, 1074, 1075 MAUZA/WILL. - SARETHI, TEHSIL - SADAR, DISTT. - AYODHYA

DWG TITLE
SITE PLAN
COORDINATED PLUMBING LAYOUT

<input type="checkbox"/> FOR TENDER/ MOCK UP	<input checked="" type="checkbox"/> FOR INFORMATION
<input type="checkbox"/> FOR EXECUTION	<input type="checkbox"/> FOR APPROVAL
DEALT BY: ANHAVI	CHECKED BY: S.
DATE: 31.07.2025	SCALE: 1:350 @ A1
DWG. NO. PL-01	TYPE: REV. NO.